




(TO FULLY COMPLY WITH BS7671:2008) Height LIGHTING Pendant light fitting (Low SWITCHES Height ____ be supplied to Local Authority (Verifier) prior to construction posts completion testing is required. Separating wall construction (U = 0) Twin frame twin stud wall with sheating. Separating wall to have effective edge sealing & to be fully filled – Edge sealing is to prevent air going in or out of the cavity. The sealing is to be fully filled with mineral wool insulation. Where required 25 mm service zone void formed by timber battens and finished with 12.5 mm plasterboard.

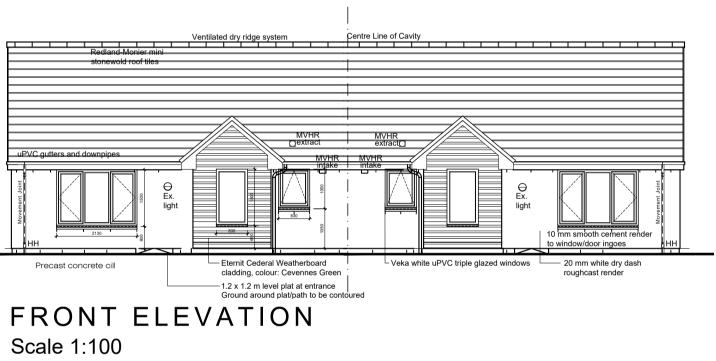

1:100 (

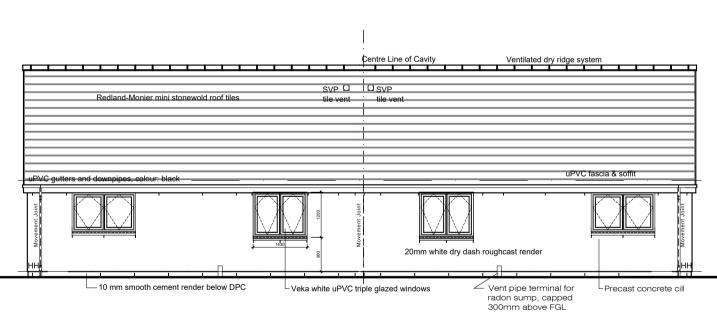


REAR ELEVATION Scale 1:100

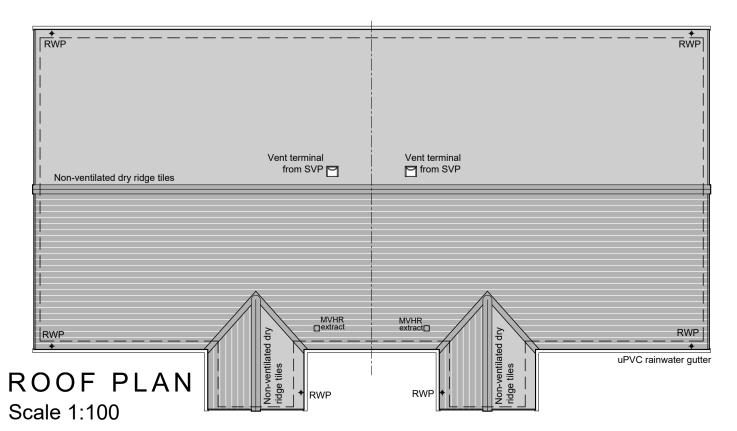



ELECTRICAL LEGEND


۲ ₂	Light switch	1050	Θ	Energy Light Bulb Fitted)	
0	Two way light switch	1050		Shrouded light fitting (Low	
Ozza	Pull cord switch	[to cord end]	 →	Energy Light Bulb Fitted) Wall light fitting	2050
SOCKET	S	Height	\$ Ì⊅	Under Wall unit Spotlight fittin	g
ŧ RG	External socket with RCD			(IP65 rating for wet areas) Spotlight fitting (IP65 rating fo	r
	Multiple retractable 13amp sw socket outlet (housed within w		~	wet areas)	
**	Twin 13amp switched socket outlet	450		External light fitting with Photocell & movement sensor (Max 100 lamp - watts per light)	2050
**	Twin 13amp switched socket outlet (worktop level)	1050	1050 <u>VENTILATION</u> H		Heigh
Ę,¢	Switched fused spur point (High level/ low level) Switch at worktop level	2200/600 1050		Trickle vent - ducted at ceiling level to outside using proprietary slim ducts.	g 2200
	Cooker control unit for hob & oven with low level connection point	1050 n 500			
≭ X	Fused spur point switched from multi gang appliance as noted	l on	0 OTHER	ITEMS POINT 6.	Heigh
_	drawing(High level/ low level)	1050	FIRE ALA	RM SYSTEM : Entire fire alarm	system to
	Multi gang switch - appliance noted on plan		be minimu	Im Category D to BS 5839 Part	
N	Central heating control unit	1050	(®	EN 14604 : 2005 and wired via p protected circuit, interconnected	bermanent & to any other
ĊP	Central heating weather comp (North facing Wal only)	pensator		/ falarm within the dwelling. Minime / to light fitting 300mm.	um distance
HS ┌──	Heating Thermostat	1050		Heat alarm conforming to BS 54 2003 wired via permanent & pro	tected circui
sv 🖓	Shaver outlet	1200		/interconnected to any other smo / within the dwelling. Minimum dis / fitting 300mm.	
μ	TV Aerial Co-axial	450		lonisation smoke alarms to confo 14604: 2005 wired via permaner	
⊔BT	British Telecom Outlet	450		circuit, interconnected to any oth alarm within the dwelling. Minimi- to light fitting 300mm.	ner smoke
	Shower - Spec by Client				
	SS TO MANUAL CONTROLS : w handle locations & heights			Consumer unit	1400
$\wedge \mathbf{x}$	XXmm (Max height of window h	nandle)	© ⊊	Door bell push Door bell sounder	1050 1050
IN	TERNAL PA	RTIT	ION	LEGEND	
	Partition - Type 2 Load Bearing With Sound Attenuation Requirement	ents		artition Type 1 - Non - Load Bearing Vith Sound Attenuation Requirements	
			—— P	artition Type 1A - Non - Load Bearing O Sound Attenuation Requirements	
LB	Indicates Load Bearing Partition			dicates partition is to be easily emountable	
	Type 2A - Partition Load Bearing No Sound Attenuation Requirement	ts		obust wall construction behind sanitar	rvware
			tc m	o provide substrate suitable to take fut nounting of grab rails, all per Figure 3. tandard 3.12.3	úre
	Indicates Load Bearing Partition				
EX	TERNAL W	/ALL	LEG	END	
∧ ── ──	EWT-1 Walls(WT		closed pan	el hybird warm timber frame con	struction.
+ 420		zone vo	oid formed b board. Min 5	all external walls internally. 35 m y timber battens and finished with 0mm cavity with concrete block o	h 15 mm
<u>↓</u>	WT-2 Walls (WT	Frame	 with sheath 	comply with Robust Detail V-WT- ning board. The development site e registered with RDL, Purchase s	e and each




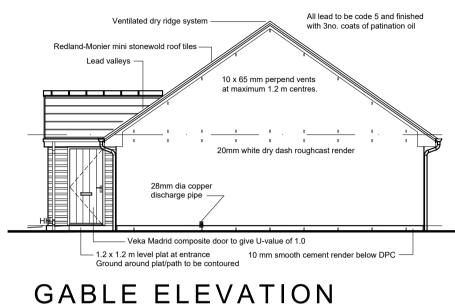

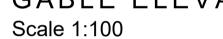


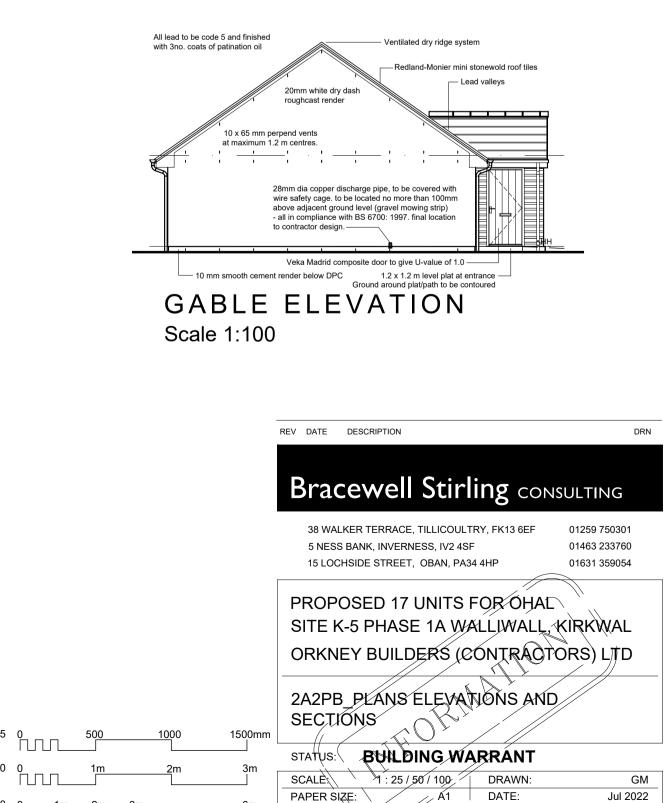


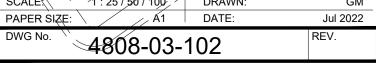

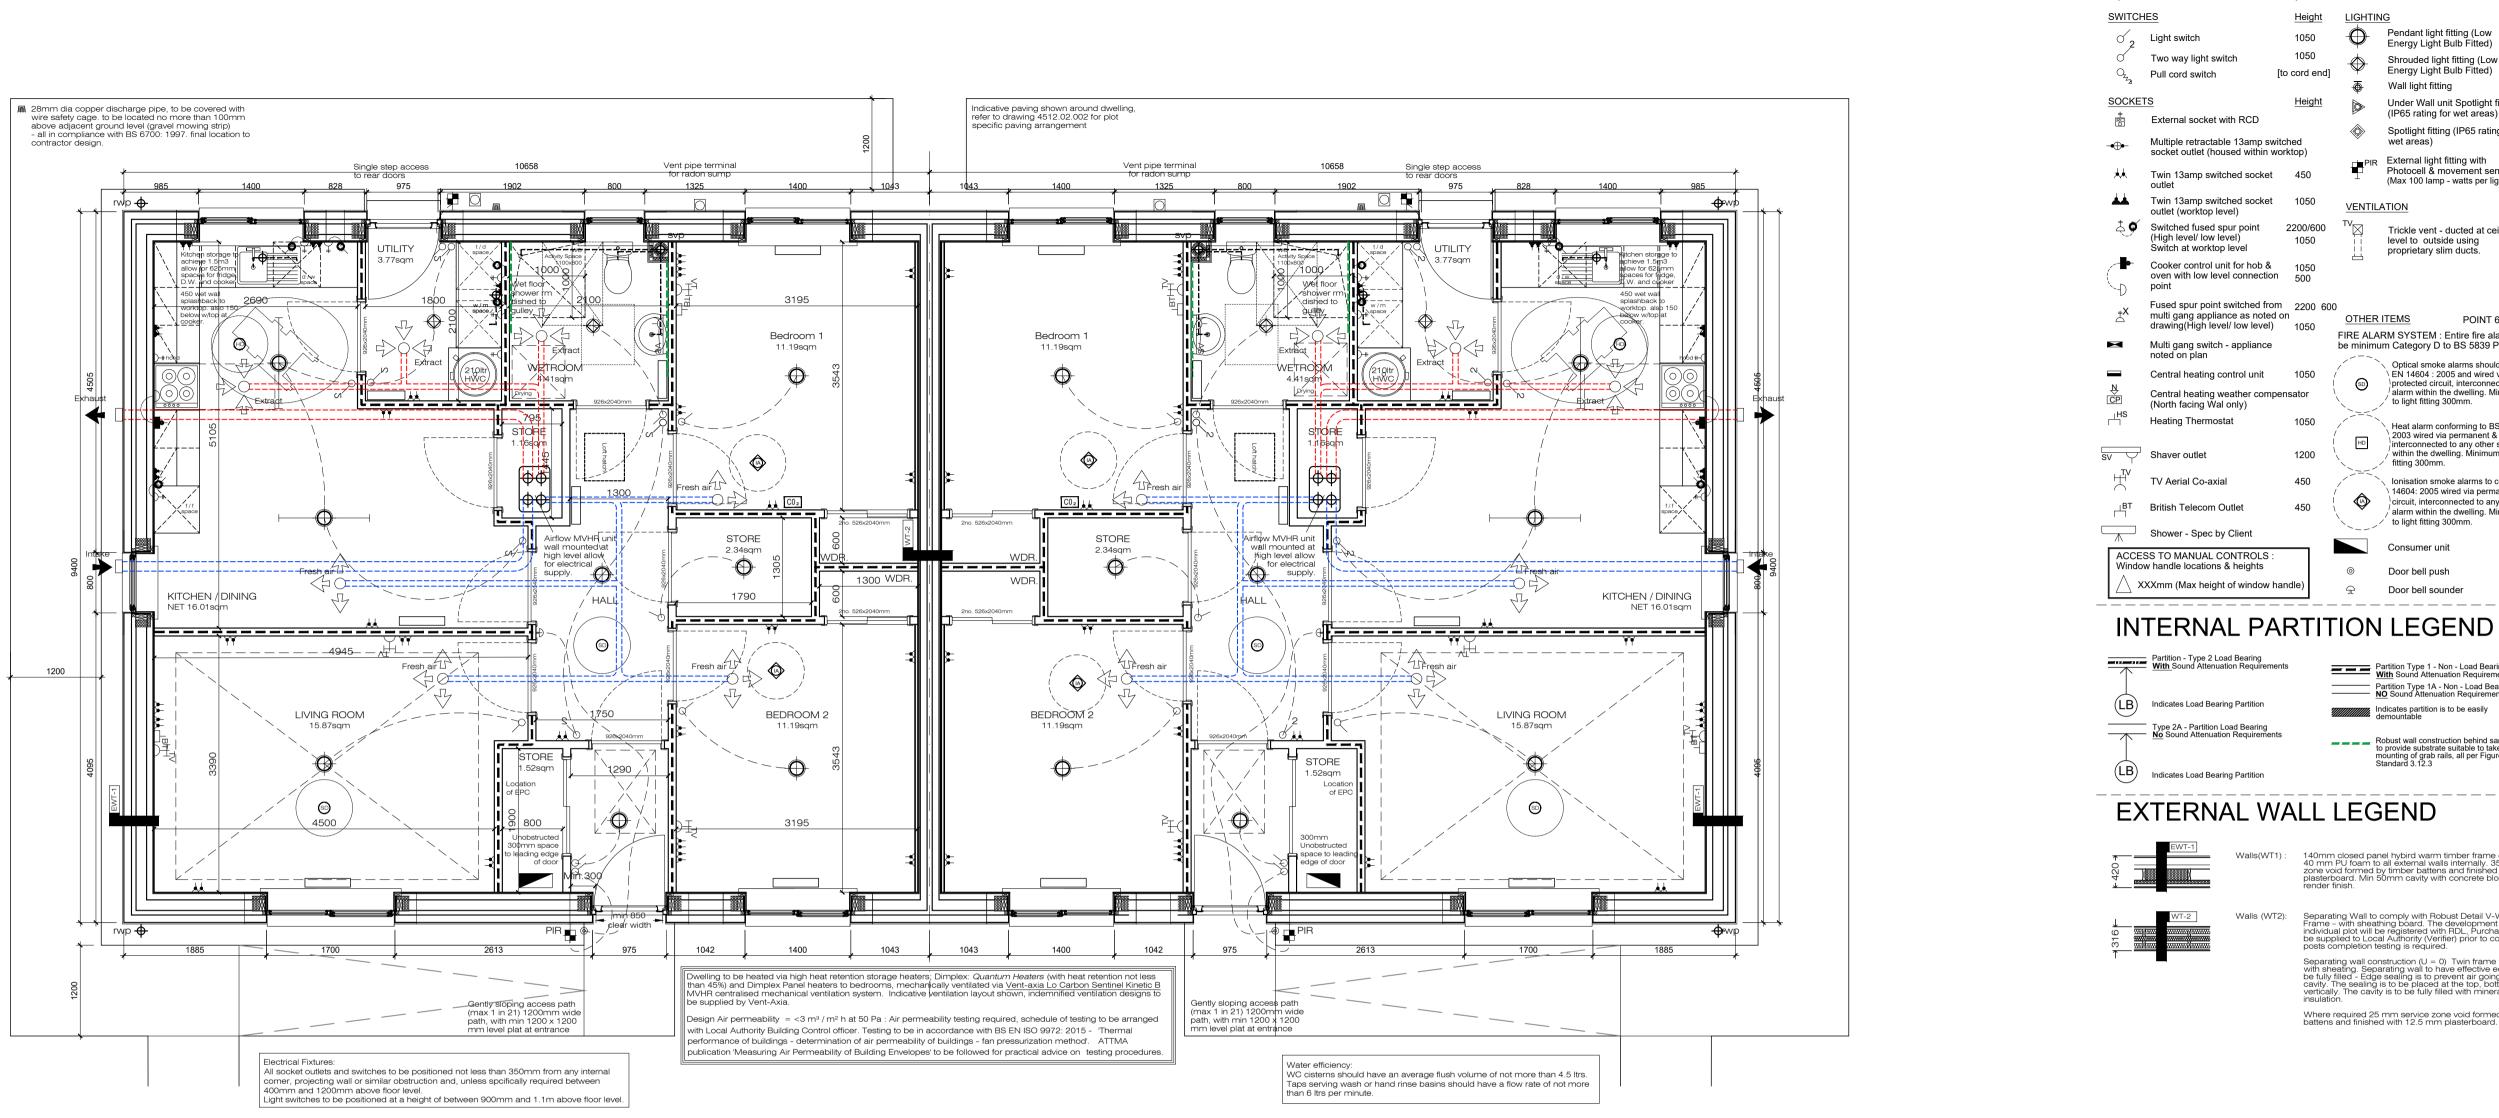

GROUND FLOOR PLAN Scale 1:50

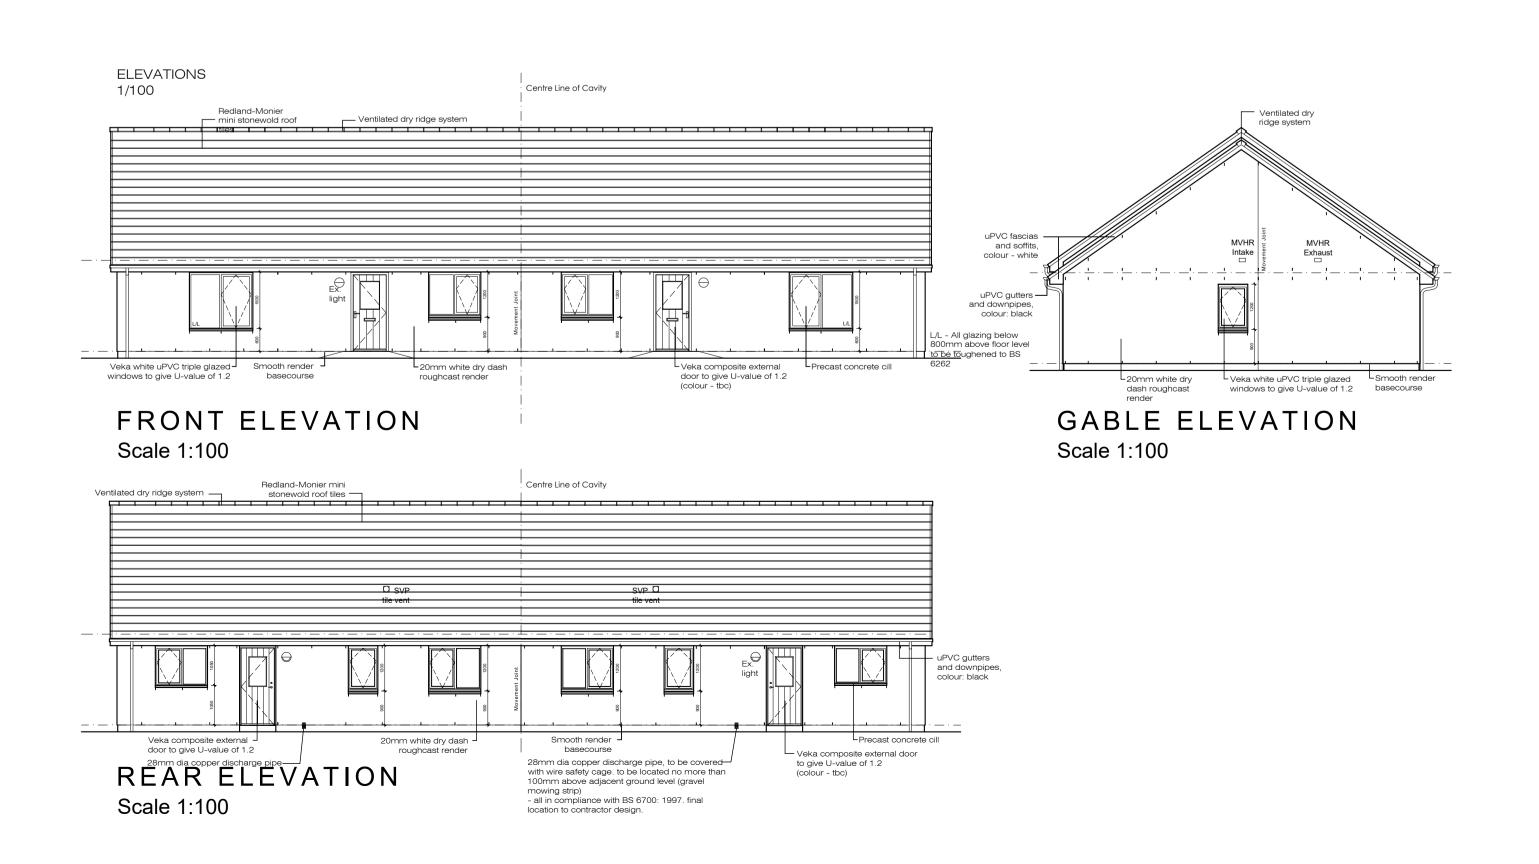

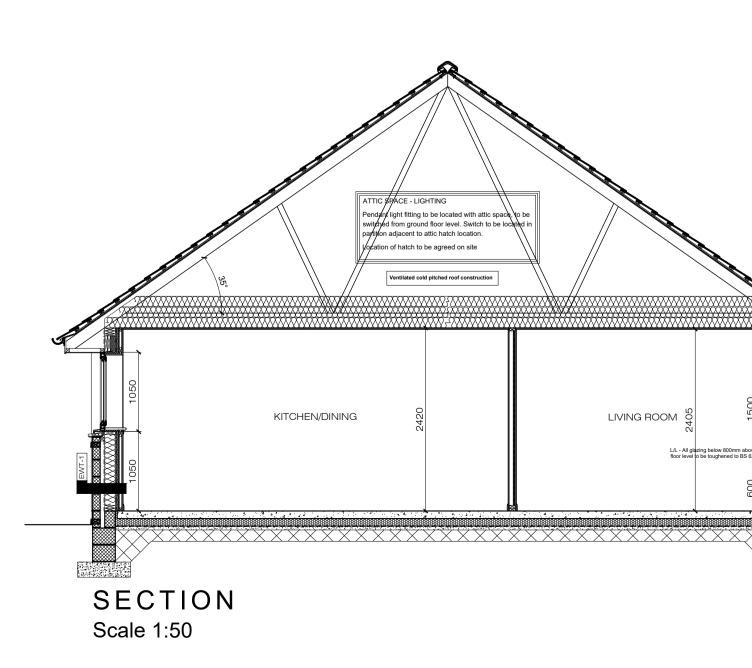

ELECTRICAL LEGEND

(TO FULLY COMPLY WITH BS7671:2008

LIGHTIN	Height		
\odot	Pendant light fitting (Low Energy Light Bulb Fitted)		
\Diamond	Shrouded light fitting (Low Energy Light Bulb Fitted)		
$\overline{\Phi}$	Wall light fitting	2050	
	Under Wall unit Spotlight fitting (IP65 rating for wet areas)		
	Spotlight fitting (IP65 rating for wet areas)		
	External light fitting with Photocell & movement sensor (Max 100 lamp - watts per light)	2050	
VENTIL	VENTILATION		
	Trickle vent - ducted at ceiling level to outside using proprietary slim ducts.	2200	

OTHER ITEMS POINT 6. <u>Height</u> FIRE ALARM SYSTEM : Entire fire alarm system to be minimum Category D to BS 5839 Part 6: 2019

((((() () () () () () () ()	Optical smoke alarms should EN 14604 : 2005 and wired v protected circuit, interconnec alarm within the dwelling. Mir to light fitting 300mm.	ia permanent & ted to any other
HD	Heat alarm conforming to BS 2003 wired via permanent & interconnected to any other s within the dwelling. Minimum fitting 300mm.	protected circuit, moke alarm
	lonisation smoke alarms to cc 14604: 2005 wired via perma circuit, interconnected to any alarm within the dwelling. Mir to light fitting 300mm.	nent & protected other smoke
	Consumer unit	1400
0	Door bell push	1050
A	Door bell sounder	1050

Partition Type 1 - Non - Load Bearing <u>With</u> Sound Attenuation Requirements Partition Type 1A - Non - Load Bearing <u>NO</u> Sound Attenuation Requirements
Indicates partition is to be easily demountable

Robust wall construction behind sanitaryware to provide substrate suitable to take future mounting of grab rails, all per Figure 3.32 of Standard 3.12.3

140mm closed panel hybird warm timber frame construction. 40 mm PU foam to all external walls internally. 35 mm service zone void formed by timber battens and finished with 15 mm plasterboard. Min 50mm cavity with concrete block cladding and render finish.

Separating Wall to comply with Robust Detail V-WT-2[™]: Timber Frame – with sheathing board. The development site and each individual plot will be registered with RDL, Purchase Statement to be supplied to Local Authority (Verifier) prior to construction. No posts completion testing is required. Separating wall construction (U = 0) Twin frame twin stud wall with sheating. Separating wall to have effective edge sealing & to be fully filled - Edge sealing is to prevent air going in or out of the cavity. The sealing is to be fully filled with mineral wool insulation

Where required 25 mm service zone void formed by timber battens and finished with 12.5 mm plasterboard.

Note to Designers and Contractors Under the CDM2015 regulations BSC has sought to eliminate or reduce risks where possible as part of the design process. Significant residual risks, or areas of work that require special attention during construction, which have been identified by BSC, are

indicated on project drawings by the following symbol <u>A</u> . t is anticipated that other designers and

contractors will co-operate to identify any potential construction hazards and to eliminate them were possible. Measures to minimise residual hazards will be

reviewed on a regular basis.

REV DATE DESCRIPTION

Bracewell Stirling CONSULTING 38 WALKER TERRACE, TILLICOULTRY, FK13 6EF 01259 750301 5 NESS BANK, INVERNESS, IV2 4SF 01463 233760 15 LOCHSIDE STREET, OBAN, PA34 4HP 01631 359054 PROPOSED 17 UNITS FOR OHAL SITE K-5 PHASE 1A WALLIWALL, KIRKWAL ORKNEY BUILDERS (CONTRACTORS) LITD 3A4PB PLANS, ELEVANONS AND SECTION STATUS: BUILDING WARRANT $\frown \checkmark$ SCALE: 1 : 50 DRAWN: GM PAPER SIZE: A1 DATE: Jul 2022 REV. DWG No. 4808-03-202

DRN

